

F.A.S. RTE.	SECTION	COUNTY	TOTAL SHEETS	SHEET NO.
TR 14	99-11117-00-BR	SHELBY	13	1
FED. ROAD DIST. NO.	ILLINOIS	FED. AID PROJECT		

91290

INDEX OF DRAWINGS

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- 3-4 SOIL EROSION AND SEDIMENT CONTROL PLAN
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- 10-13 BRIDGE PLANS

STATE OF ILLINOIS DEPARTMENT OF TRANSPORTATION PLANS FOR PROPOSED BRIDGE REPLACEMENT AND REHABILITATION PROGRAM

**TOWNSHIP ROAD T.R. 14
SECTION 99-11117-00-BR
OCONEE ROAD DISTRICT
SHELBY COUNTY
STRUCTURE NO. 087-3517
PROJECT NO. BR OS-173 (122)**

JOB NO. C-95-070-03

REQUIRED HIGHWAY STANDARDS

- 000001-04 STANDARD SYMBOLS, ABBREVIATIONS AND PATTERNS
- 280001-02 TEMPORARY EROSION CONTROL SYSTEMS
- 515001-02 NAME PLATE FOR BRIDGES
- 630001-04 STEEL PLATE BEAM GUARDRAIL
- 702001-03 TRAFFIC CONTROL DEVICES
- BLR21-6 TYPICAL APPLICATION OF TRAFFIC CONTROL DEVICES


UTILITY COMPANIES

FRONTIER COMMUNICATION
MR. GRAIG CYRULIS
117 W. JEFFERSON
MT. PULASKI, ILLINOIS 62548
1-217-792-5772

SHELBY ELECTRIC COOPERATIVE
MR. JIM MATLOCK
P.O. BOX 560.
SHELBYVILLE, ILLINOIS 62565
1-217-774-3986

EXISTING STRUCTURE NO. 087-3056
SINGLE SPAN CONCRETE DECK BRIDGE
26'-10" BK. TO BK. ABUTMENTS WITH
A WIDTH OF 16'-0", 3' HIGH CONCRETE
WALLS EACH SIDE OF BRIDGE CLOSED
CONCRETE ABUTMENTS AND WINGWALLS

BEGIN IMPROVEMENT
STA. 4+00.00

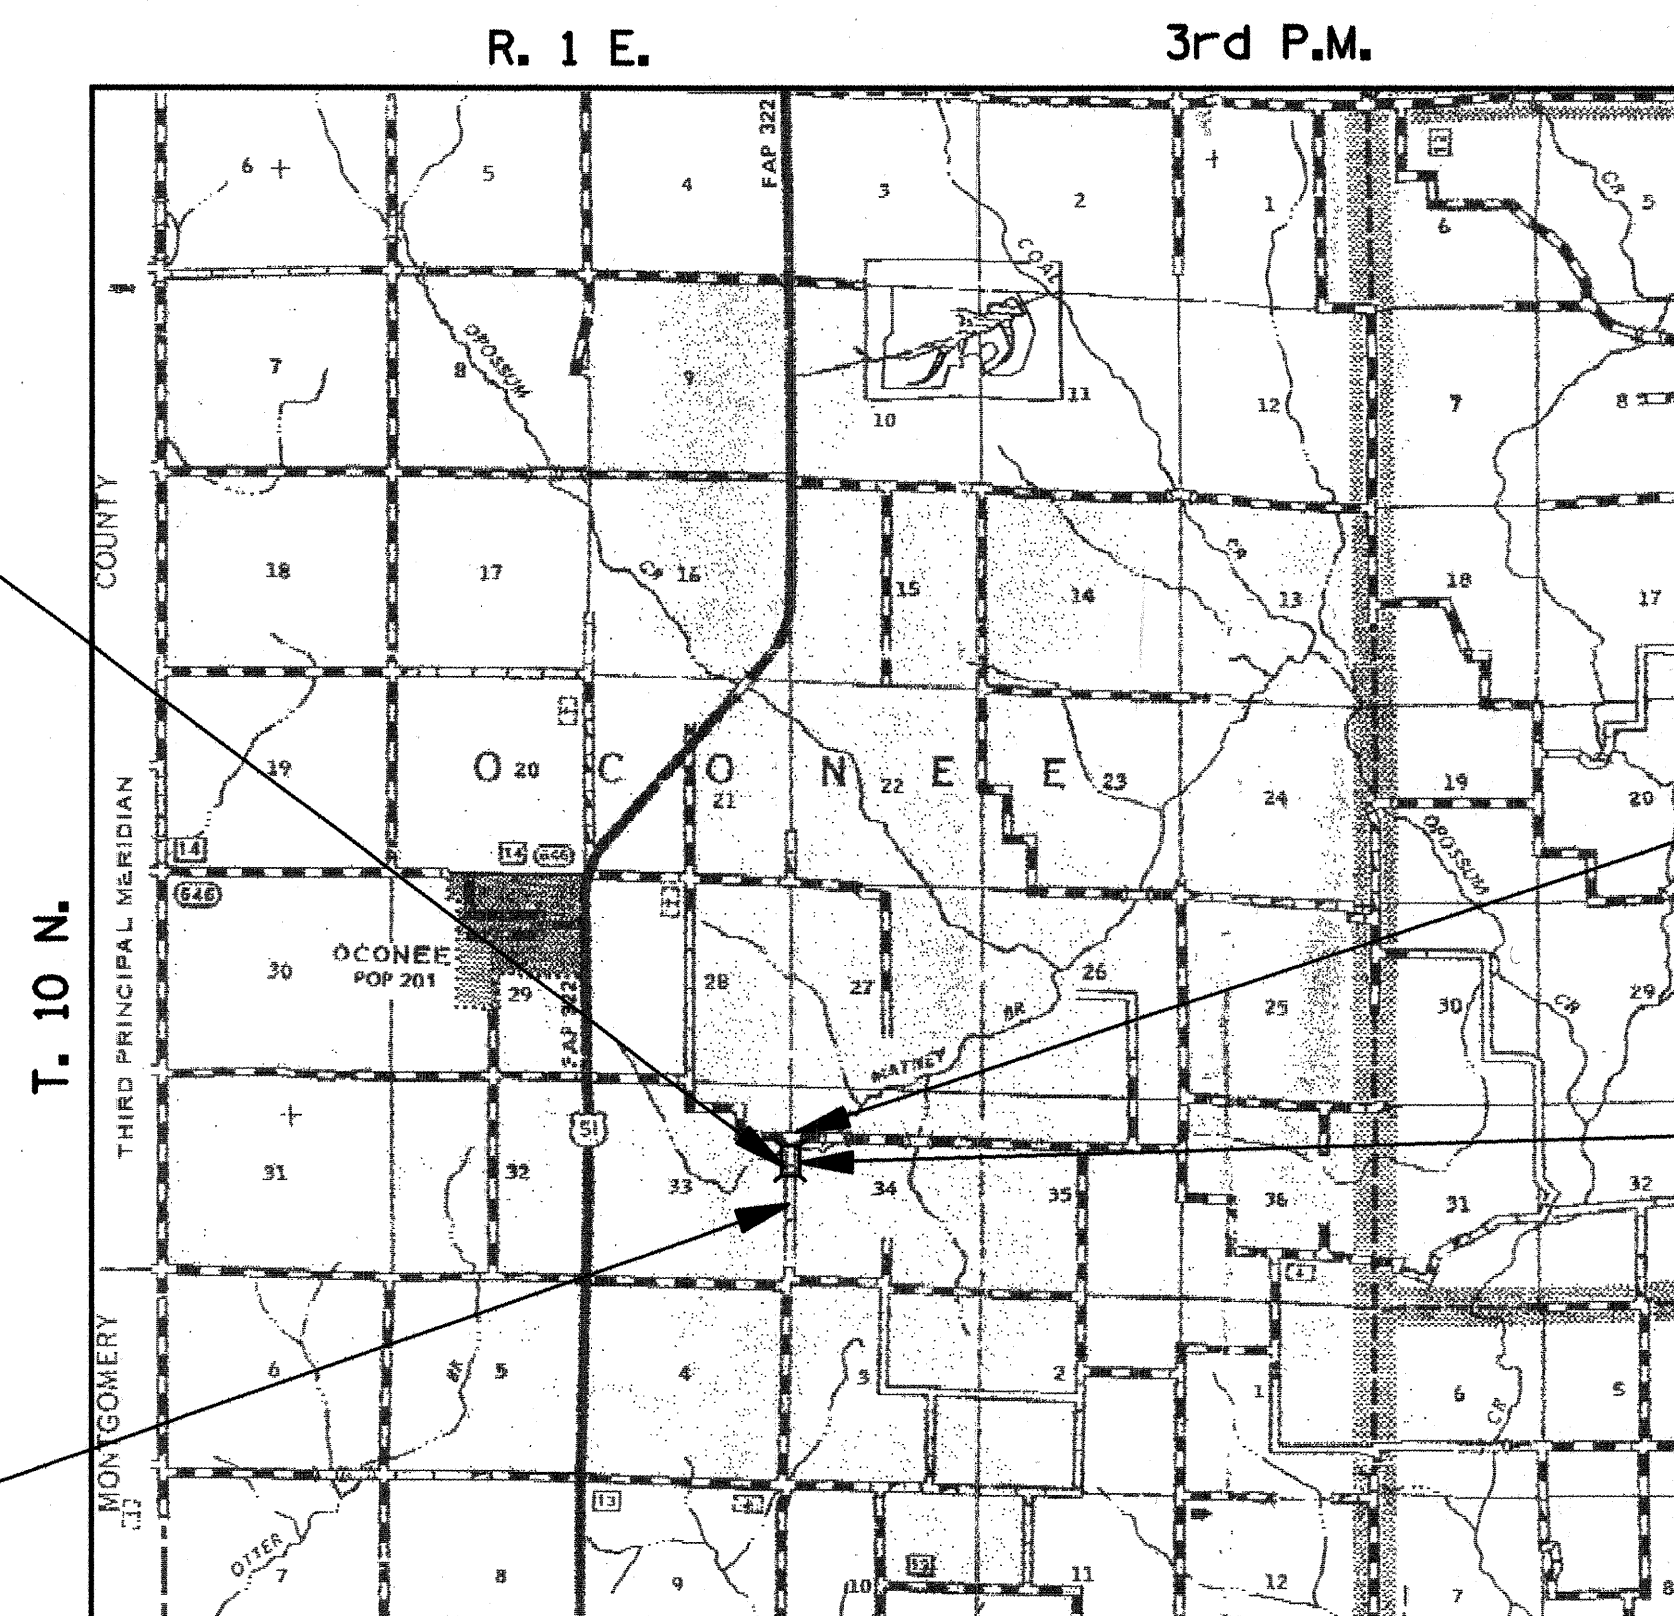

END IMPROVEMENT
STA. 9+92.40

SPECIAL BRIDGE DESIGN

STATION 8+12.00
ONE SPAN 27" P.P.C. DECK BEAM BRIDGE
SPAN 60'-0", 63'-0" BK. TO BK. ABUTMENTS
24'-0" CLEAR WIDTH ON PILE BENT ABUTMENTS
PROPOSED STRUCTURE NO. 087-3517

SCALES	PLAN	1" = 50'	0 50 100
	PROFILE HORIZ.	1" = 50'	0 50 100
	PROFILE VERT.	1" = 5'	0 5 10
	CROSS SECTIONS HORIZ.	1" = 10'	0 10 20
	CROSS SECTIONS VERT.	1" = 5'	0 5 10

The acceptance of this project is based on the minimum design criteria for a Federal-Aid Bridge Replacement and Rehabilitation Improvement.

APPROVED 12-05 20 03
[Signature]
County Engineer

APPROVED 12-03 20 03
[Signature]
Highway Commissioner

PASSED 12/22 20 03
[Signature]
District Engineer of Local Roads & Streets

APPROVED 12-22 20 03
[Signature]
District Engineer

STATE OF ILLINOIS
DEPARTMENT OF TRANSPORTATION

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iechicago@ie-consultants.com

LOCATION MAP
0 1 2 MILES
APPROXIMATE SCALE : 1" = 1 MILE
NET LENGTH OF SECTION = 592.40 FEET = 0.112 MILES
FUNCTIONAL CLASSIFICATION : LOCAL ROAD

CONTRACT NO. 91290 CURRENT ADT <150
DESIGN ADT <150



[Signature] 10-22-03
David Booher, Illinois P.E. 062-043769 Date
Expires 11-30-2003